



SECOND FLOOR
 SCALE: 1/8" = 1'-0"


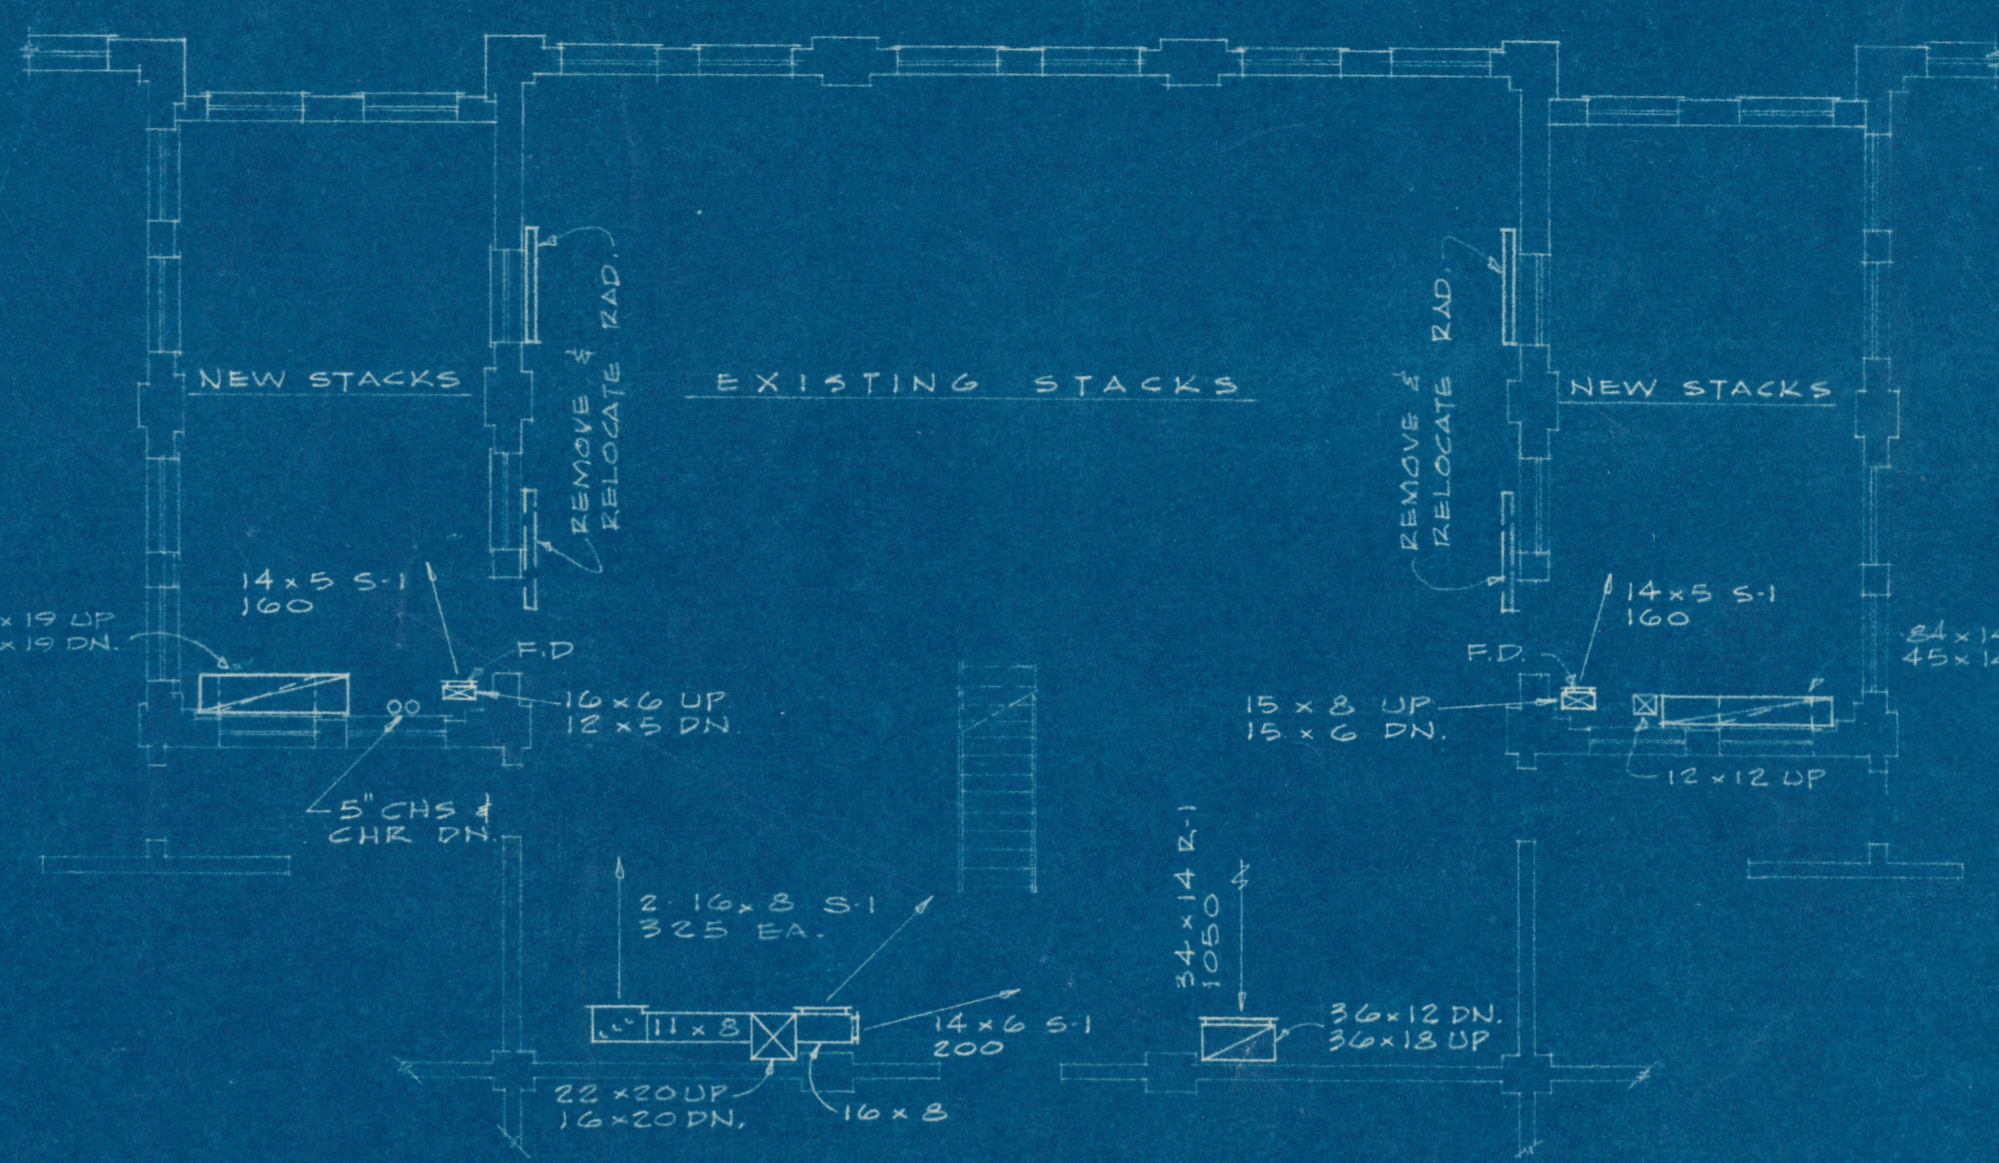


PARTIAL PLAN - STACKS - THIRD LEVEL
 SCALE: 1/8" = 1'-0"

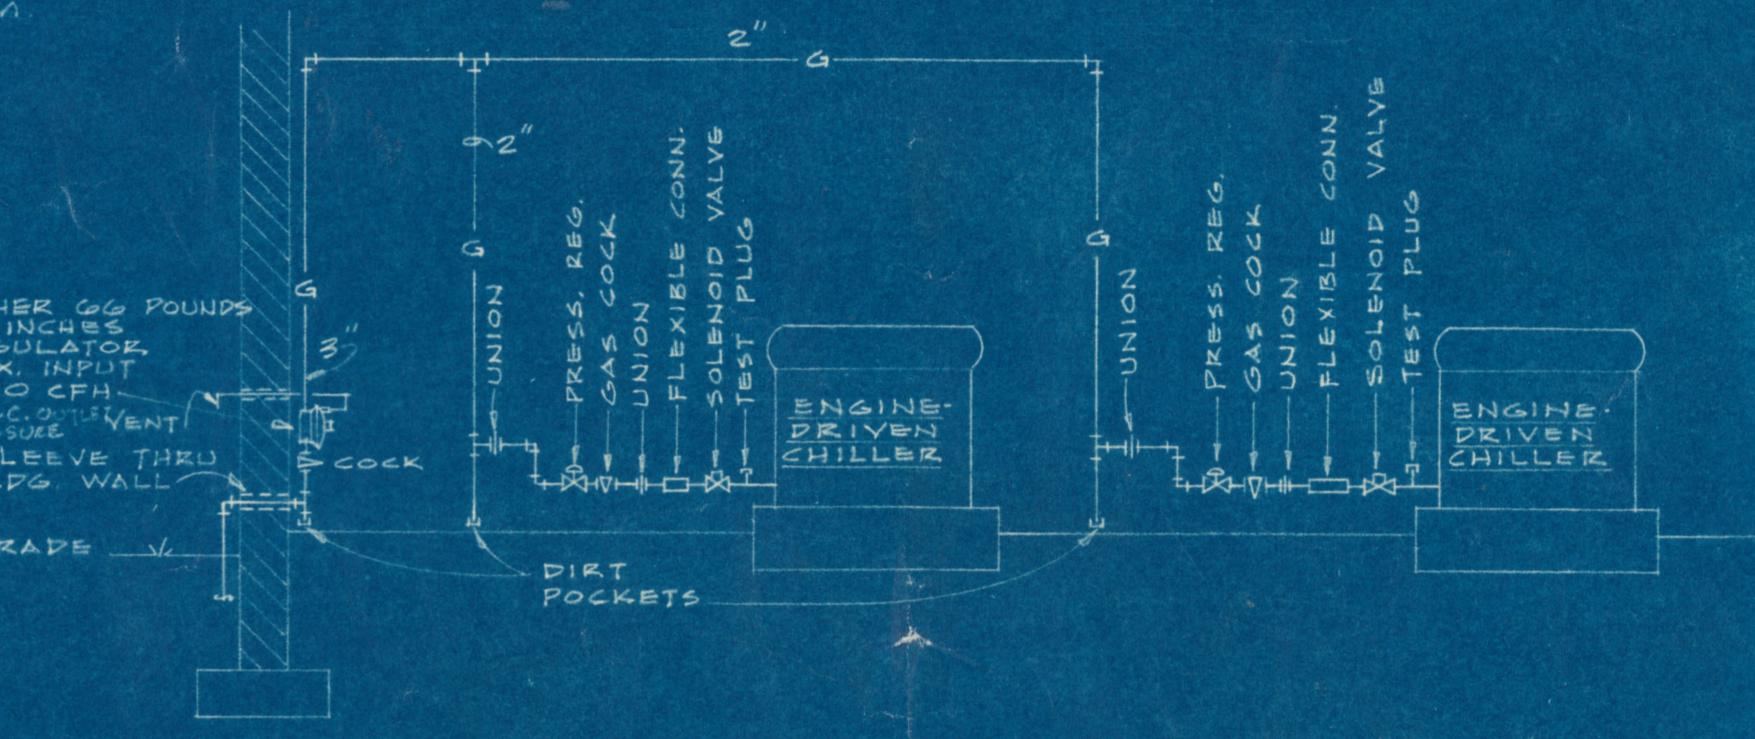


LEGEND

SYMBOL	ABBREV.	DESCRIPTION
CHS	CHS	CHILLED WATER SUPPLY
CHR	CHR	CHILLED WATER RETURN
CS	CS	CONDENSER SUPPLY
CR	CR	CONDENSER RETURN
G	G	GAS
EXH	EXH	EXHAUST
D	D	DRAIN
GV	GV	GATE VALVE
GLV	GLV	GLOBE VALVE
CHK.V	CHK.V	CHECK VALVE
C.V	C.V	CONTROL VALVE
STR.	STR.	STRAINER
		THERMOMETER
		PRESSURE GAGE
		DIRECTION OF FLOW
		DIRECTION OF DRAINAGE
AV	AV	AUTOMATIC AIR VENT
		THERMOSTAT COOLING
		FIRE DAMPER

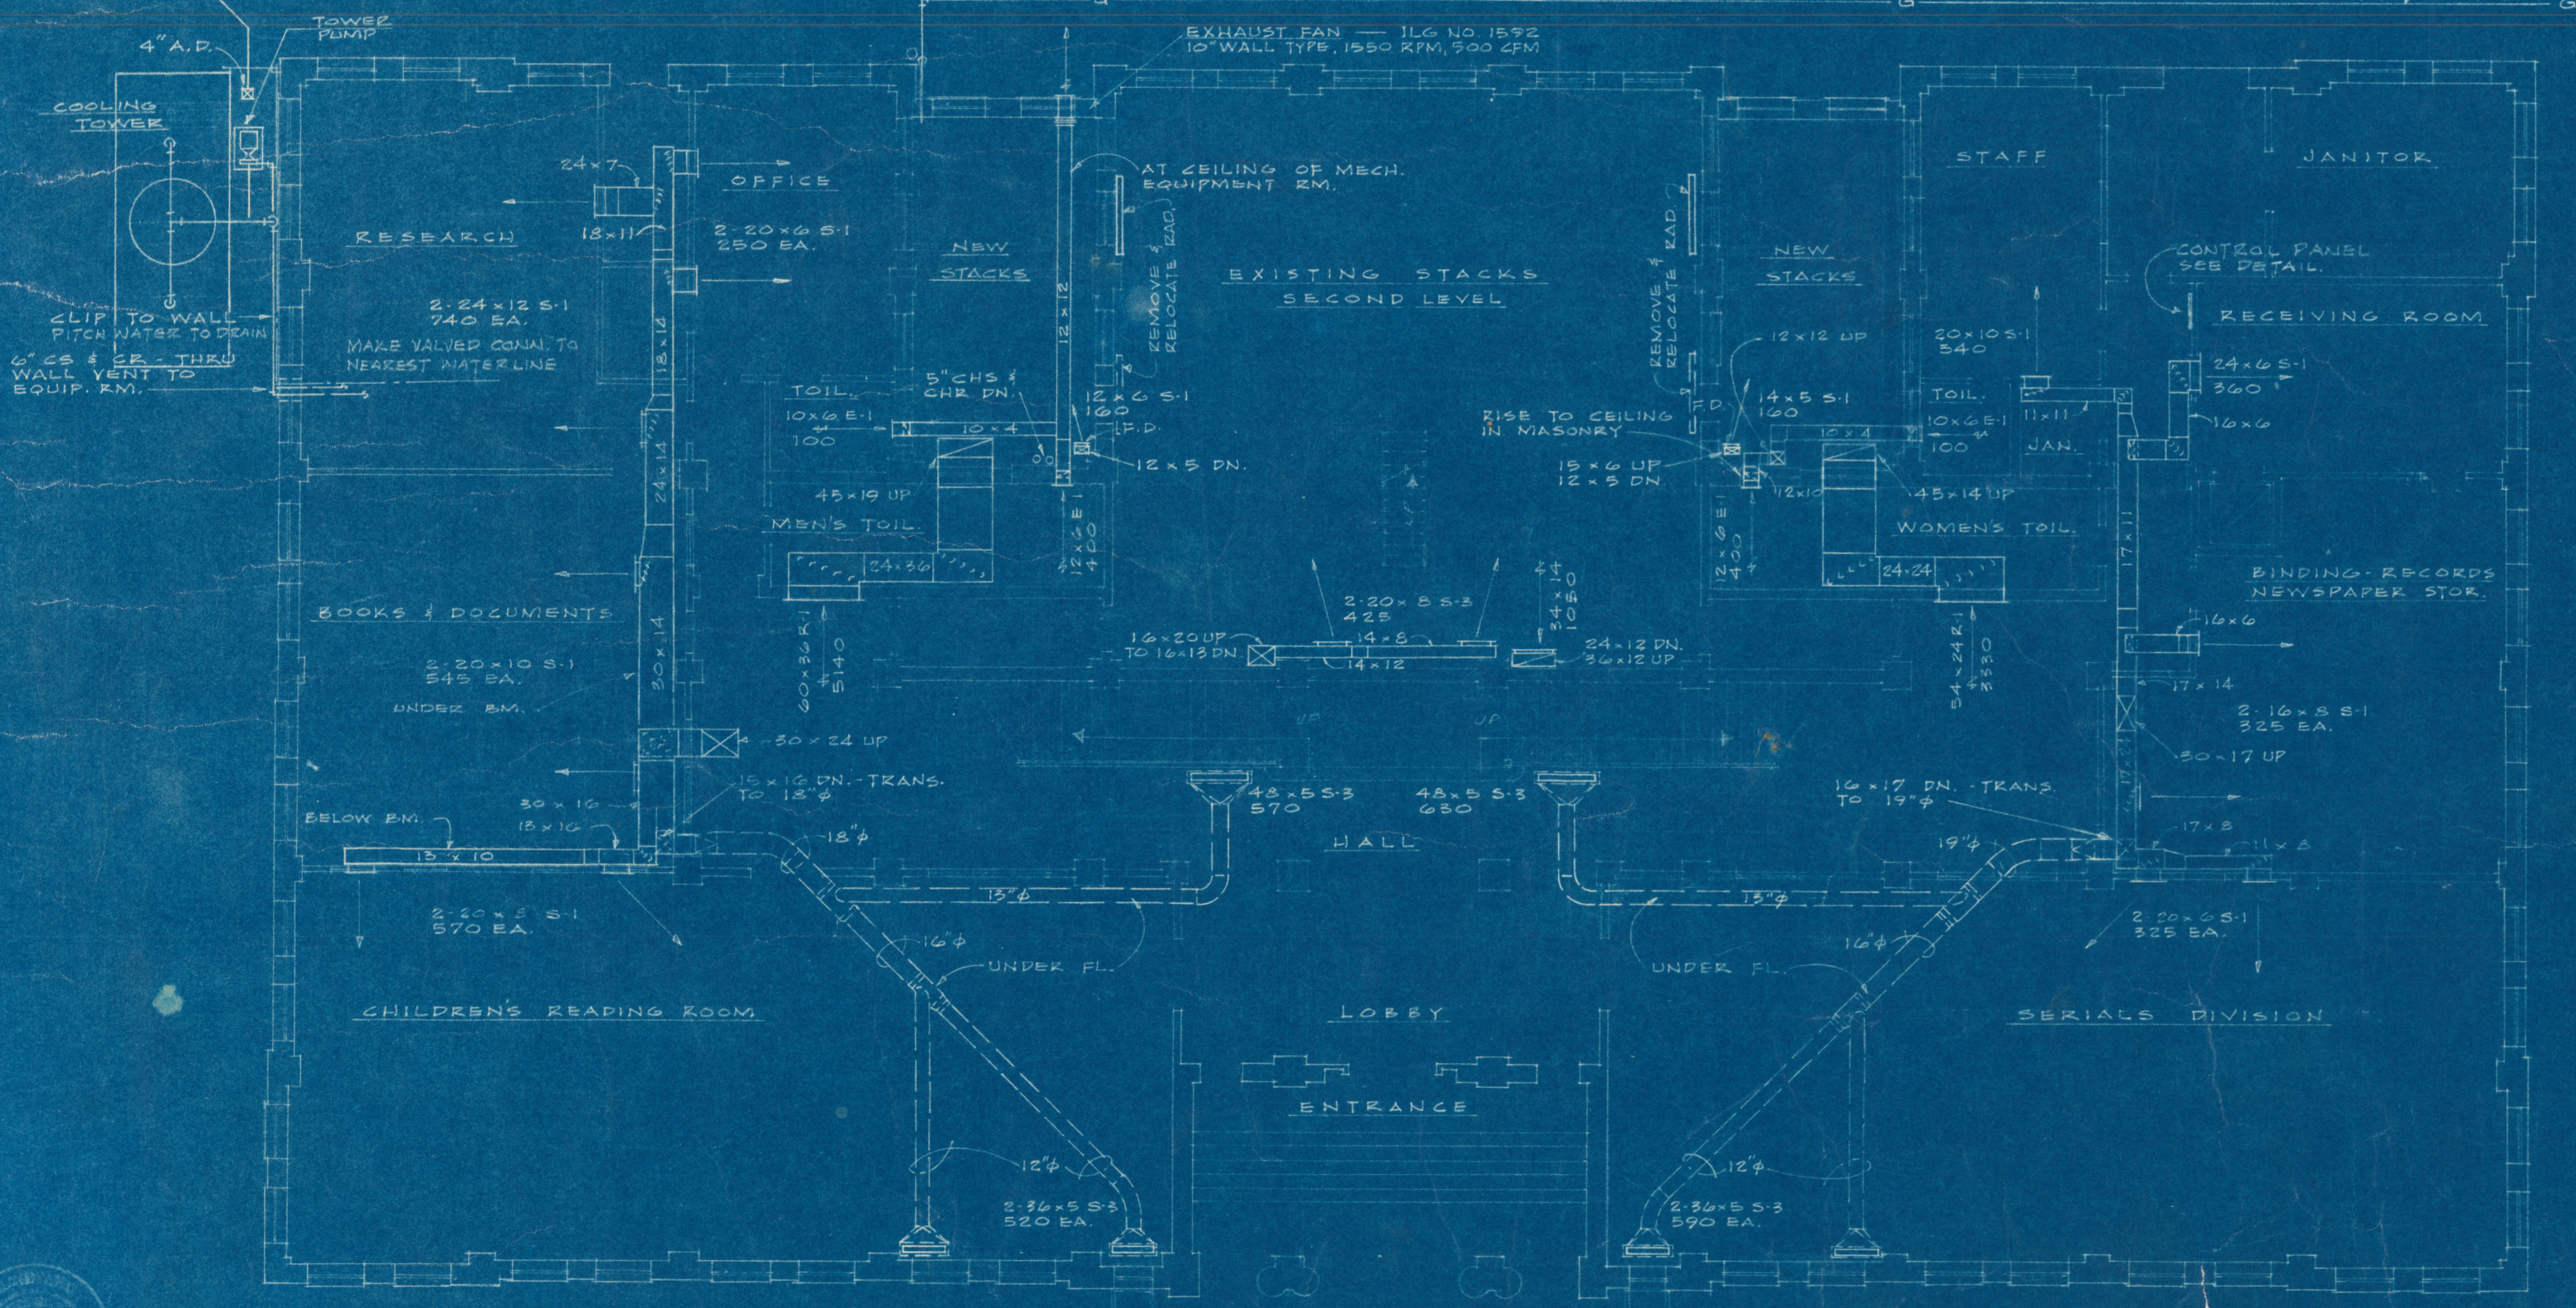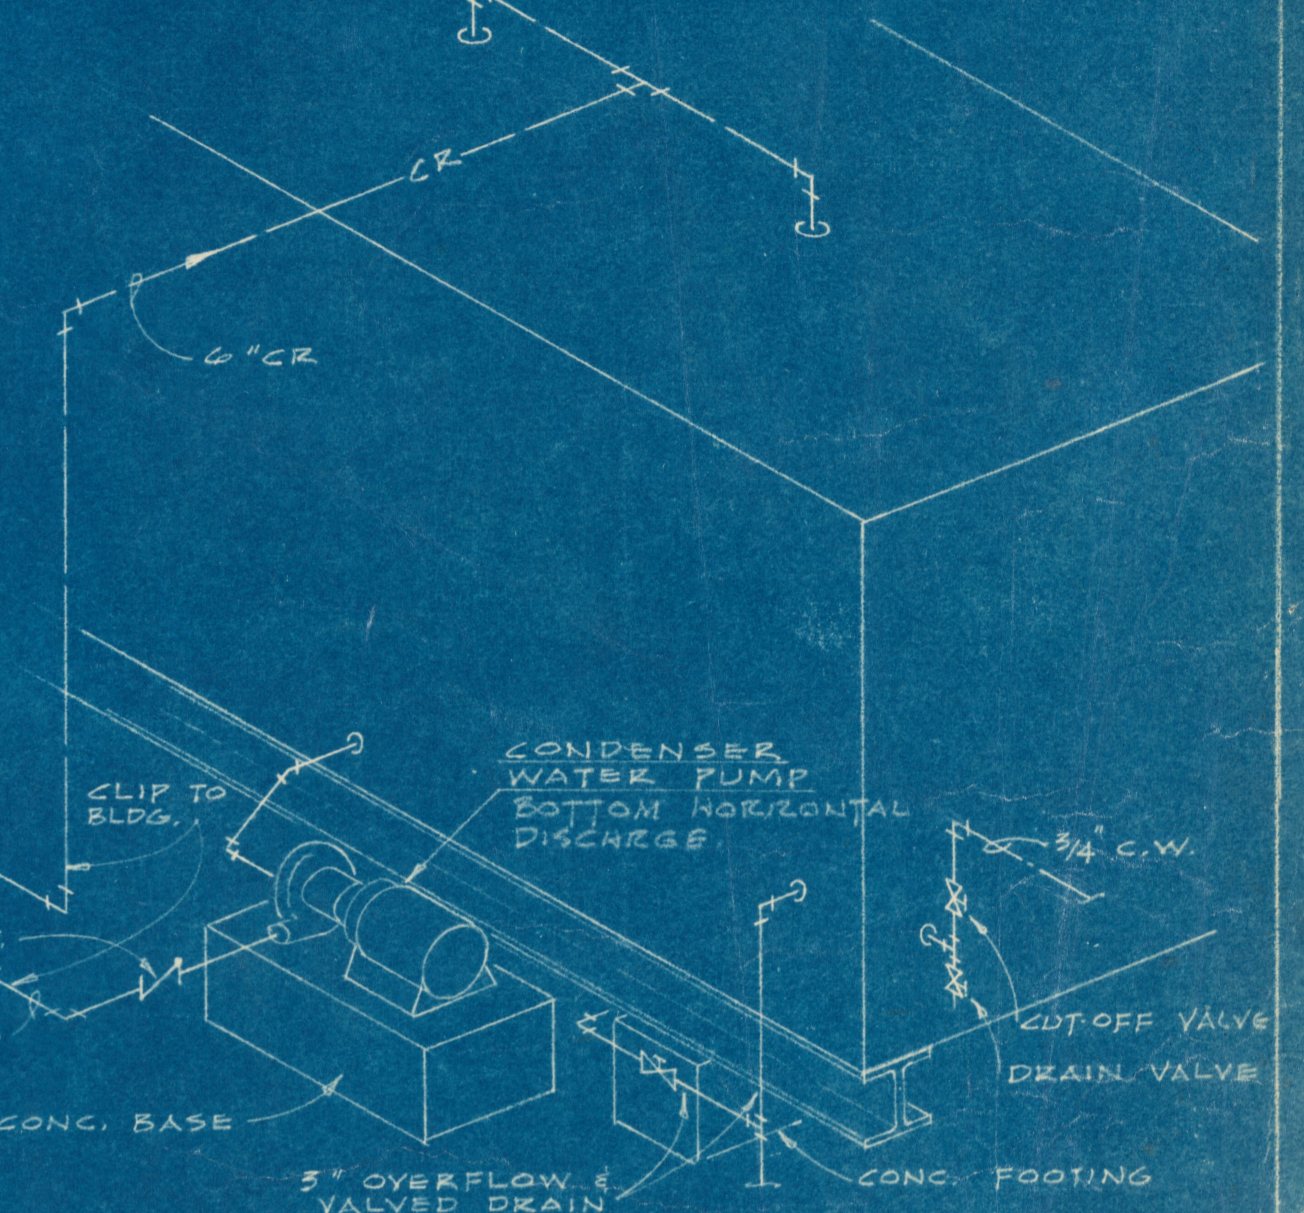



FIRST FLOOR
 SCALE: 1/8" = 1'-0"

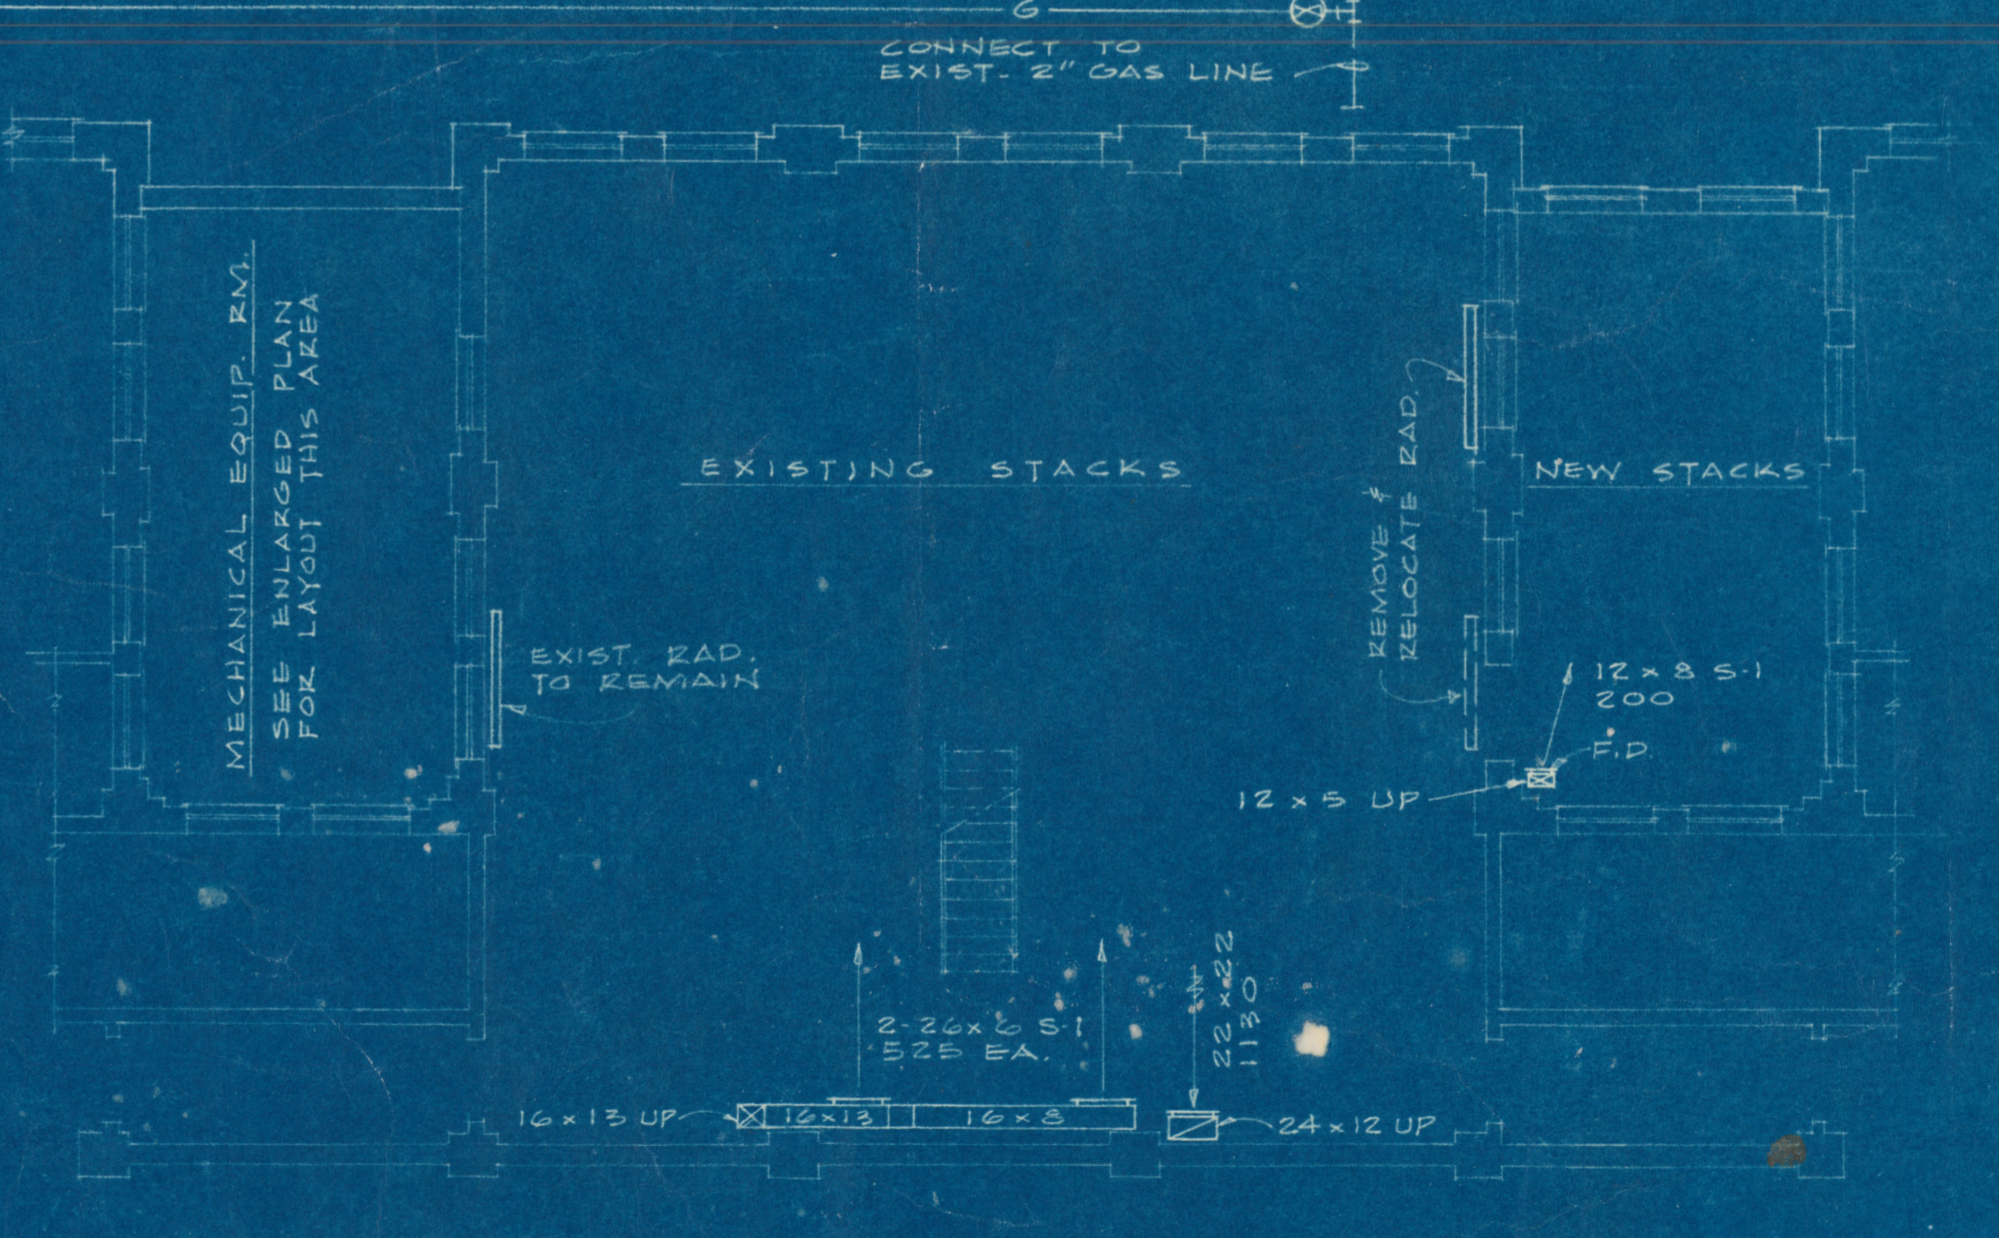

PARTIAL PLAN - STACKS - FIRST LEVEL
 FIRST FL.

GRILLES, REGISTERS, & DIFFUSERS

SYMBOL	TYPE	MFG. & MODEL	REMARKS
S-1	SUPPLY SIDEWALL REG.	WATERLOO X25HO	
S-2	SUPPLY CEILING DIFF.	ANEMOSTAT EA1 W/GU-2	
S-3	SUPPLY FLOOR REG.	WATERLOO AL250	BORDER STYLE NO. 3
R-1	RETURN SIDEWALL REG.	WATERLOO X25HO	
E-1	EXHAUST SIDEWALL REG.	WATERLOO 610	1/8" STAMPED ALUM. LATTICE TYPE FACE

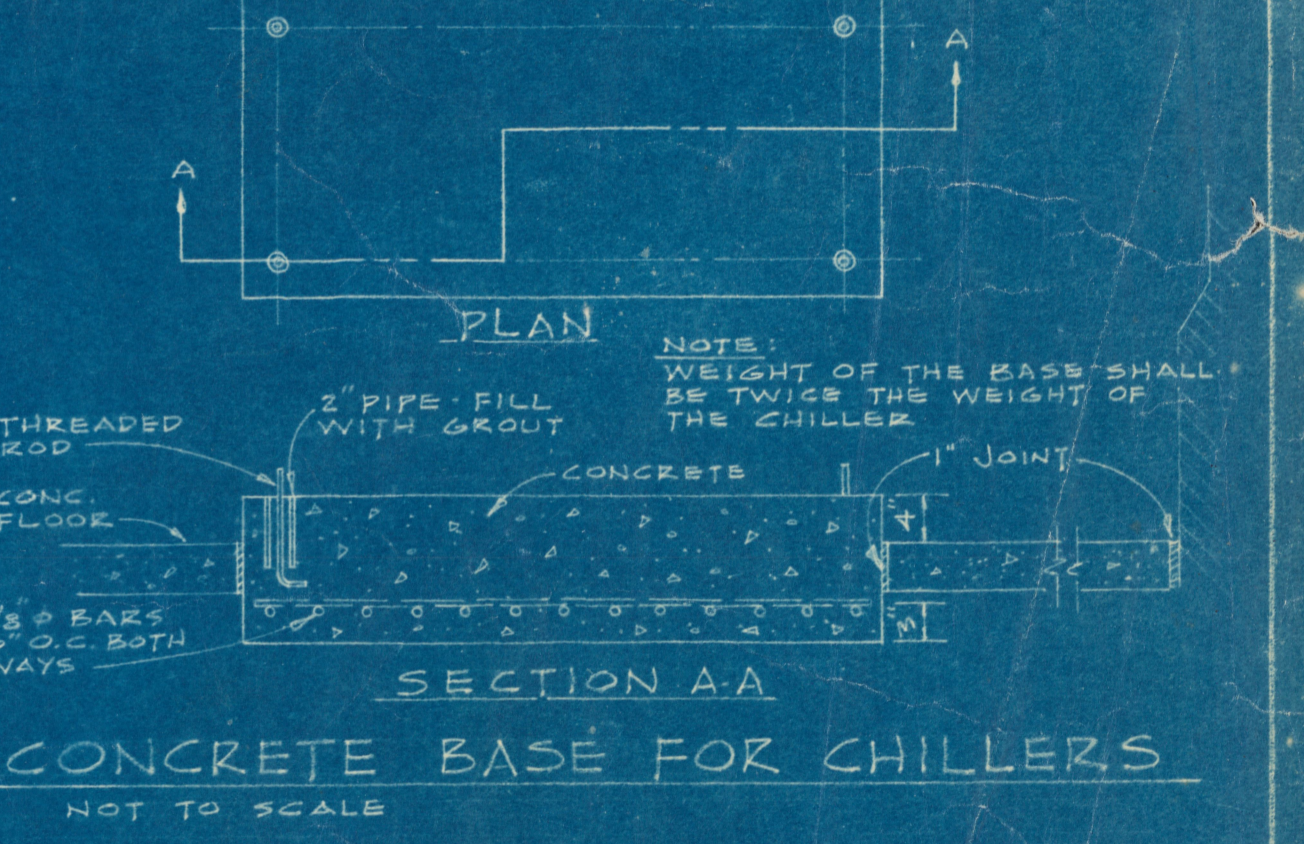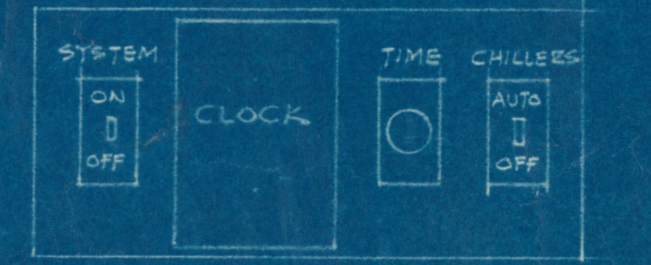

ADDITION & RENOVATION LIBRARY BUILDING
 PROJECT NO. ALA. 4-0361 TUSKEGEE INSTITUTE TUSKEGEE INSTITUTE, ALABAMA

HEATING, VENTILATING AND AIR CONDITIONING

FIRST & SECOND FLOOR PLANS

MILLER AND ALLAIN, ARCHITECTS
 ATLANTA, GEORGIA

DRAWN: [Signature]
 TRACED: [Signature]
 APPROVED: [Signature]
 ISSUE DATE: 12-10-65
 DRAWING NO. M-1